
Proposed New Outdoor Dining Area

Yamstick Cafe
84 High Street
Bowraville 2449

1/DP334892

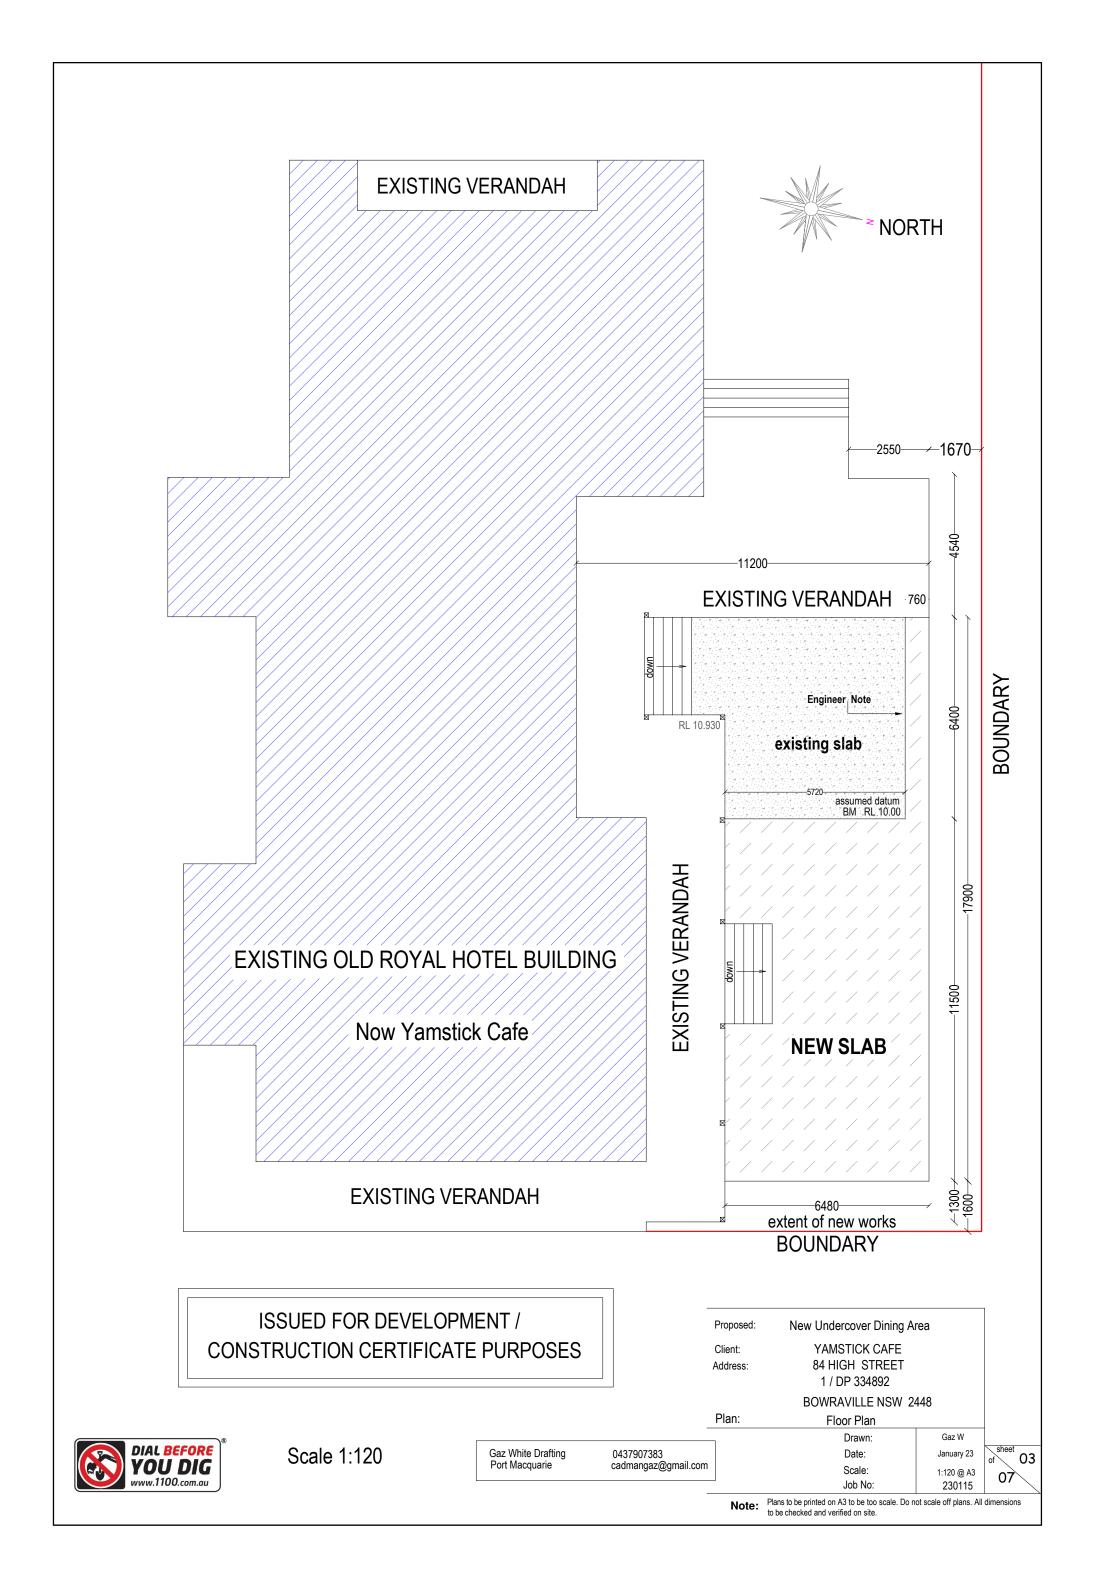

Specifications

Plans to be read in conjunction with the structual engineers details

Plans to be read in conjunction with frame & truss design

Builder to provide erosion & sediment control barrier

An accredited service provider to remove waste building materials from site

All dimensions to be confirmed prior to fabrication & construction.

Do NOT scale drawings

All construction to comply with the NCC, BCA & relevent Australian Standards

Electricial Installations to be in accordance with AS 3000

Earthworks to be in accordance with BCA 3.1.1. Levels to be confirmed on site by builder or surveyor prior to excavation

Earth retaining structures to be in accordance with BCA 3.1.2. & AS4678

Drainage to be in accordance with BCA 3.1.3. & AS3500

Termite protection to be in accordance with BCA 3.1.4. & AS3660

Concrete slab & Footings to the Structual Engineers details & in accordance with BCA 3.2.2, BCA 3.2.3, BCA 3.2.5.

AS1684, AS2870, AS3600 & AS4100

Termite Protection

BCA 3.1.3.1.B acceptable construction practice requires compliance to satisfy requirement P2.1

The intent is to provide for a termite barrier that will ensure that termites will not enter a building by a concealed route

- 1. Termimesh system by approved installer to concrete slabs
- 2. Termiquard chemical system by approved installer
- 3. Continuous antcap to floor perimeter walls, isolated antcaps to piers.

Gutters & Downpipes

Fascia, gutters & downpipes to be colourbond fixed to manufacturers instructions & in accoedance with BCA Part 3.5.2 & AS 2179

Condensation management to be in accordance with BCA 3.8.7. & AS4200 Stairs to be slip resistant in accordance with BCA 3.9.1.4. Barriers & handrails to be in accordance with BCA 3.9.2. & AS1170

all structual steel to be measured ON SITE

Plan:

Slab Footing Construction Notes

Concrete slabs & footings to engineers details Slabs & footings to be in accordance with AS2870 Strip underside area of all topsoil, debris & organic matter

material, an engineering inspection must be carried out

Edge rebates not less than 20mm & external masonary must not overhang slab by more than 15mm

Vapour barrier under slabs 200um medium impact resistant branded polythene film with laps not less than 200mm at all joints. Tape & seal with a close fitting sleeve around all service penetrations

Masonry construction to be in accordance with BCA 3.3, AS3700 & AS4773 NOTE: Client has advised the new roof will be covered with Solar Panels Portal frame design and connection details as per Engineering specifications. Steel Roof Cladding -Steel Gutter existing deck beyond new concrete slab to structual Engineeers details Structual steel columns & roofing beams existing entry steps Note.: New Structual Steel completely isolated from existing structure Bowraville Conservation Area Significance : Local **EAST ELEVATION** Royal Hotel Significance -6480-

BUILDER to confirm dimensions ON SITE with Structual Steel Fabricator prior to manufacturing of Steel components **Extent of new Undercover Dining Area**

Steel framing to be in accordance with BCA 3.4.2. AS4100 & AS4600

Structual steel members to be in accordance with BCA 3.4.4. AS4100 & AS4600

Sheet roofing to be installed in accordance with BCA 3.5.1. & AS1562

Lights to be in accordance with BCA 3.8.4. & AS1680

Gutters & downpipes to be in accordance with BCA 3.5.3. Downpipes locations to AS3500

Fire Safety to be in accordance with BCA 3.6, AS1288, & AS1562 Smoke alarms to be installed in accordance with BCA 3.7.5. AS3786 & the manufacturers specifications. Smoke alarms to be interconnected & connected to mains power. Waterproofing to be in accordance with AS3740 & BCA table 3.8.1.1

ISSUED FOR DEVELOPMENT / CONSTRUCTION CERTIFICATE PURPOSES Proposed: New Undercover Dining Area


YAMSTICK CAFE Client: 84 HIGH STREET Address: 1 / DP 334892

> **BOWRAVILLE NSW 2448** East Elevation

Gaz White Drafting 0437907383 Port Macquarie cadmangaz@gmail.com

Drawn: Gaz W 06 Date: January 23 Scale: 1:100 @ A3 Job No: 230115

Plans to be printed on A3 to be too scale. Do not scale off plans. All dimensions to be checked and verified on site

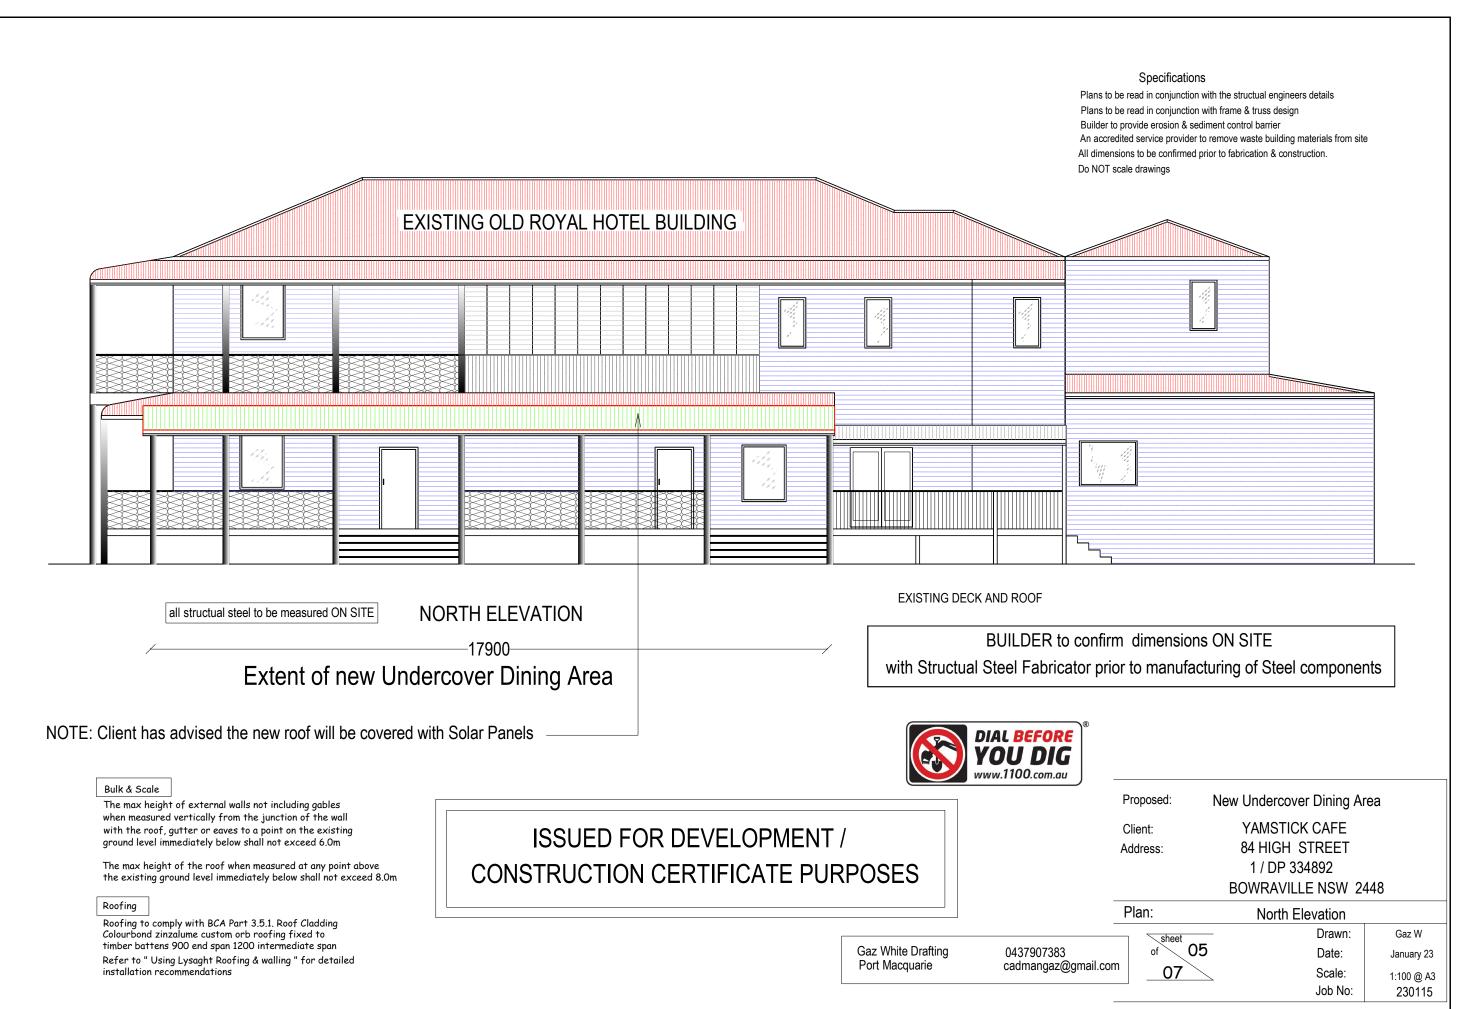

e: Plans to be printed on A3 to be too scale. Do not scale off plans. All dimensions to be checked and verified on site.

